
BARGE

ASSEMBLY PLANT EXPANSION NISSAN NORTH AMERICA

300 NISSAN DR, CANTON, MS 39046

GENERAL EROSION NOTES:

- THE STORMWATER POLLUTION PREVENTION PLAN IS COMPRISED OF THE EROSION CONTROL DRAWINGS ("SITE MAP"), THE STANDARD DETAILS, AND THE SPECIFICATIONS SECTION 01 57 13, PLUS THE NPDES PERMIT AND ALL SUBSEQUENT REPORTS AND RELATED DOCUMENTS.
- THE STORM WATER POLLUTION PREVENTION PLAN AND THE STATE OF MISSISSIPPI NATIONAL POLLUTANT DISCHARGE
- CONTRACTOR SHALL IMPLEMENT BEST MANAGEMENT PRACTICES AS REQUIRED BY THE SWPPP. ADDITIONAL BEST MANAGEMENT PHASES OF CONSTRUCTION.
- BEST MANAGEMENT PRACTICES (BMP'S) AND CONTROLS SHALL CONFORM TO FEDERAL, STATE, OR LOCAL REQUIREMENTS OR MANUAL OF PRACTICE, AS APPLICABLE, CONTRACTOR SHALL IMPLEMENT ADDITIONAL CONTROLS AS DIRECTED BY PERMITTING AGENCY OR OWNER.
- SITE MAP MUST CLEARLY DELINEATE ALL STATE WATERS. PERMITS FOR ANY CONSTRUCTION ACTIVITY IMPACTING STATE WATERS OR REGULATED WETLANDS MUST BE MAINTAINED ON SITE AT ALL TIMES.
- CONTRACTOR SHALL MINIMIZE CLEARING TO THE MAXIMUM EXTENT PRACTICAL OR AS REQUIRED BY THE GENERAL PERMIT.
- GENERAL CONTRACTOR SHALL DENOTE ON PLAN THE TEMPORARY PARKING AND STORAGE AREA WHICH SHALL ALSO BE USED AS THE EQUIPMENT MAINTENANCE AND CLEANING AREA, EMPLOYEE PARKING AREA, AND AREA FOR LOCATING PORTABLE FACILITIES, OFFICE TRAILERS, AND TOILET FACILITIES.
- ALL WASH WATER (CONCRETE TRUCKS, VEHICLES CLEANING, EQUIPMENTS CLEANING, ETC.) SHALL BE DETAINED AND PROPERLY
- SUFFICIENT OIL AND GREASE ABSORBING MATERIALS AND FLOTATION BOOMS SHALL BE MAINTAINED ON SITE OR READILY AVAILABLE TO CONTAIN AND CLEAN-UP FUEL OR CHEMICAL SPILLS AND LEAKS. CONTRACTOR SHALL FOLLOW MDEQ REQUIREMENTS AS APPROPRIATE.
- 10. DUST ON THE SITE SHALL BE CONTROLLED. THE USE OF MOTOR OILS AND OTHER PETROLEUM BASED OR TOXIC LIQUIDS FOR
- 11. RUBBISH, TRASH, GARBAGE, LITTER, OR OTHER SUCH MATERIALS SHALL BE DEPOSITED INTO SEALED CONTAINERS. MATERIALS SHALL BE PREVENTED FROM LEAVING THE PREMISES THROUGH THE ACTION OF WIND OR STORMWATER DISCHARGE INTO
- 12. ALL STORM WATER POLLUTION PREVENTION MEASURES PRESENTED ON THESE PLANS. AND IN THE STORM WATER POLLUTION
- 13. DISTURBED PORTIONS OF THE SITE WHERE CONSTRUCTION ACTIVITY WILL BE STOPPED FOR AT LEAST 14 DAYS SHALL BI TEMPORARILY STABILIZED.
- 14. DISTURBED PORTIONS OF THE SITE WHERE CONSTRUCTION ACTIVITY HAS PERMANENTLY STOPPED SHALL BE IMMEDIATELY
- 15. IF THE ACTION OF VEHICLES TRAVELING OVER THE GRAVEL CONSTRUCTION ENTRANCES IS NOT SUFFICIENT TO REMOVE THE MAJORITY OF DIRT OR MUD, THEN THE TIRES MUST BE WASHED BEFORE THE VEHICLES ENTER A PUBLIC ROAD OR LEAVE THE CONFINES OF THE WORK AREA. IF WASHING IS USED, PROVISIONS MUST BE MADE TO INTERCEPT THE WASH WATER AND TRAP THE SEDIMENT BEFORE IT IS CARRIED OFF THE SITE AS SHOWN IN THE EROSION CONTROL DETAILS.
- 16. ALL MATERIALS SPILLED, DROPPED, WASHED, OR TRACKED FROM VEHICLES ONTO ROADWAYS OR INTO STORM DRAINS MUST BE REMOVED IMMEDIATELY.
- 17. CONTRACTORS OR SUBCONTRACTORS WILL BE RESPONSIBLE FOR REMOVING SEDIMENT FROM THE DETENTION AND SEDIMENT PONDS AND ALL SEDIMENT THAT IS COLLECTED IN THE STORM SEWER DRAINAGE SYSTEMS IN CONJUNCTION WITH THE CONSTRUCTION OF THE SITE.
- 18. ON-SITE SOIL STOCKPILE AREAS SHALL BE PROTECTED FROM EROSION AND SEDIMENTATION THROUGH IMPLEMENTATION OF BEST MANAGEMENT PRACTICES DESIGNED BY THE QCP. STOCKPILE AND BORROW AREA LOCATIONS SHALL BE NOTED ON THE SITE MAP AND PERMITTED IN ACCORDANCE WITH GENERAL PERMIT REQUIREMENTS.
- 19. SLOPES SHALL BE LEFT IN A ROUGHENED CONDITION DURING THE GRADING PHASE TO REDUCE RUNOFF VELOCITIES AND
- 20. DUE TO THE GRADE CHANGES DURING THE DEVELOPMENT OF THE PROJECT, THE CONTRACTOR IS RESPONSIBLE FOR ADJUSTING THE EROSION CONTROL MEASURES (SILT FENCES, ETC.) TO PREVENT EROSION.
- 21. ALL CONSTRUCTION SHALL BE STABILIZED AT THE END OF EACH WORKING DAY, THIS INCLUDES BACKFILLING OF TRENCHES FOR UTILITY CONSTRUCTION AND PLACEMENT OF GRAVEL OR BITUMINOUS PAVING FOR ROAD CONSTRUCTION.
- 22. CONTRACTOR SHALL COMPLETE AND SUBMIT THE NOTICE OF INTENT (LCNOI) FOR LAND DISTURBING ACTIVITIES OF FIVE (5) OR MORE ACRES TO MISSISSIPPI DEPARTMENT OF ENVIRONMENTAL QUALITY (MDEQ) AND SHALL BE THE APPLICANT/ PERMIT HOLDER/ RESPONSIBLE ENTITY/ OPERATOR. CONTRACTOR SHALL ADHERE TO ALL REQUIREMENTS OF THE NPDES PERMIT. WORK SHALL NOT COMMENCE UNTIL PERMIT IS ISSUED.
- 23. CONTRACTOR SHALL HIRE A QUALIFIED CREDENTIALED PROFESSIONAL (QCP) FOR NOTICE OF TERMINATION (N.O.T.) CERTIFICATION AND TO PERFORM ALL MONITORING, INSPECTIONS, AND RECORD-KEEPING AS REQUIRED BY THE NPDES PERMIT.
- 24. ALL SLOPES 4:1 OR STEEPER SHALL BE HYDROSEEDED WITH MULCH, LIME, FERTILIZER, AND SEED ONCE FINAL GRADE HAS BEEN ACHIEVED. AS AN ALTERNATE, SLOPES MAY BE FERTILIZED, SEEDED, AND THEN COVERED WITH AN EROSION CONTROL BLANKET (E.C. SC150 BY NORTH AMERICAN GREEN OR APPROVED ALTERNATE).

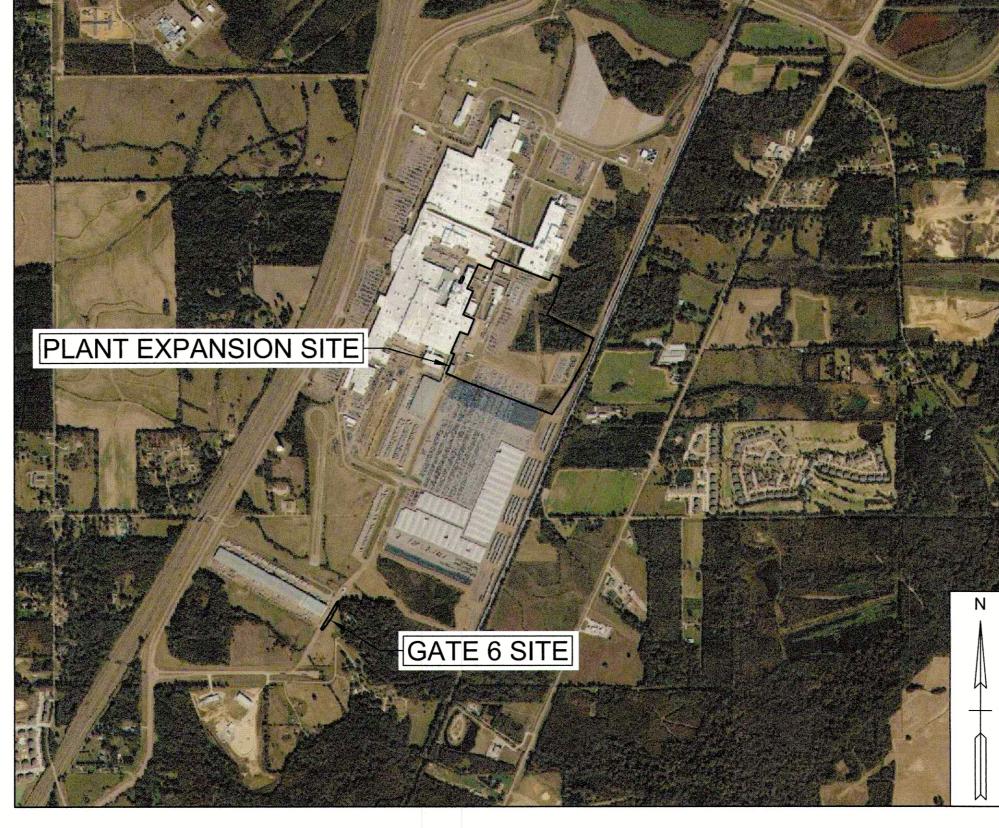

VICINITY MAP

NOT TO SCALE

ABBREVIATIONS

ARCH ARCHITECT OHP OVERHEAD POWER		
ARCH ARCHITECT OHP OVERHEAD POWER		
BMP BEST MANAGEMENT PRACTICE OHPT OVERHEAD POWER AND TE	ELEPHONE	
ELEV ELEVATION R RADIUS		
FFE FINISHED FLOOR ELEVATION REF REFERENCE		
HP HIGH POINT R.O.W. RIGHT-OF-WAY		
INV INVERT SA SANITARY SEWER		
LP LOW POINT ST STORM SEWER		
MAX MAXIMUM TYP TYPICAL		
MH MANHOLE UGE UNDERGROUND ELECTRIC		
MIN MINIMUM W WATER		

INDEX OF DRAWINGS

SHEET NO.	DESCRIPTION	
CG000	COVER SHEET	
CG141	SITE EROSION AND SEDIMENT CONTROL PLAN - PHASE I	
CG151	SITE EROSION AND SEDIMENT CONTROL PLAN - PHASE II	
CG161	SITE EROSION AND SEDIMENT CONTROL PLAN - GATE 6	
CG501	EROSION CONTROL DETAILS	
CG502	EROSION CONTROL DETAILS	
CG503	EROSION CONTROL DETAILS	
CG504	EROSION CONTROL DETAILS	

EROSION MAINTENANCE NOTES

ALL MEASURES STATED ON THIS EROSION AND SEDIMENT CONTROL PLAN, AND IN THE STORM WATER POLLUTION PREVENTION PLAN, SHALL BE MAINTAINED IN FULLY FUNCTIONAL CONDITION UNTIL NO LONGER REQUIRED FOR A COMPLETED PHASE OF WORK CONTROL MEASURES SHALL BE CHECKED BY A QUALIFIED PERSON AT LEAST ONCE EVERY SEVEN CALENDAR DAYS AND WITHIN 72

- DETERIORATION.
- ALL DISTURBED AREAS SHALL BE SEEDED OR SODDED PER MDOT SPECIFICATIONS. ALL SEEDED AREAS SHALL BE CHECKED REGULARLY TO SEE THAT A GOOD STAND IS MAINTAINED. AREAS SHALL BE FERTILIZED. WATERED. AND RE-SEEDED AS
- SILT FENCES SHALL BE REPAIRED TO THEIR ORIGINAL CONDITIONS IF DAMAGED. SEDIMENT SHALL BE REMOVED FROM THE SILT FENCES WHEN IT REACHES ONE-HALF THE HEIGHT OF THE SILT FENCE.
- THE CONSTRUCTION ENTRANCES SHALL BE MAINTAINED IN A CONDITION WHICH WILL PREVENT TRACKING OR FLOW OF MUD ONTO PUBLIC RIGHTS-OF-WAY OR OUTSIDE THE PROJECT LIMITS. THIS MAY REQUIRE PERIODIC TOP DRESSING OF THE CONSTRUCTION ENTRANCES AS CONDITIONS DEMAND.
- 5. THE TEMPORARY PARKING AND STORAGE AREA SHALL BE KEPT IN GOOD CONDITION (SUITABLE FOR PARKING AND STORAGE). THIS MAY REQUIRE PERIODIC TOP DRESSING OF THE TEMPORARY PARKING AS CONDITIONS DEMAND.

GENERAL NOTES:


- 1. THE PURPOSE OF THIS SET OF PLANS IS FOR MDEQ PERMITTING ASSOCIATED WITH THE NPDES PERMIT. THIS SET OF PLANS IS INTENDED TO BE MODIFIED BY THE CONTRACTOR AS NEEDED AS A 'SITE MAP' BASED ON THE CONSTRUCTION ACTIVITIES AND SCHEDULE AS DICTATED BY CONSTRUCTION CONDITIONS. THIS SET OF PLANS IS NOT INTENDED TO SHOW THE DEMOLITION OR RELOCATION OF ANY EXISTING FEATURES (PAVEMENT, FENCES, UTILITIES, STRUCTURES, ETC.).
- 2. PROPOSED BUILDING, PARKING, AND DRIVES TAKEN FROM '10-20-23_ROUGH GRADE_CANTONV8.DWG' PROVIDED BY NISSAN
- 3. EXISTING TOPOGRAPHY APPROXIMATED FROM 'EROSION CONTROL PLAN (EXISTING)' BY T. BAKER SMITH DATED 03/07/2023.
- 4. EXISTING STORM DRAINAGE PIPE INFORMATION TAKEN FROM "SITE UTILITIES.DWG" BY T. BAKER SMITH (RECEIVED 11/09/2023) AND MCMASTER & ASSOCIATES, INC PLANS DATED 06/26/2017 AND 07/05/2018.
- 5. WETLANDS/ WATERS INFORMATION TAKEN FROM WETLAND MAP PROVIDED BY T. BAKER SMITH ON 11/29/2023. CONTRACTOR SHALL NOT IMPACT ANY SENSITIVE AREAS (WETLANDS/ WATERS) UNTIL PERMIT ISSUANCE BY GOVERNING AUTHORITIES.










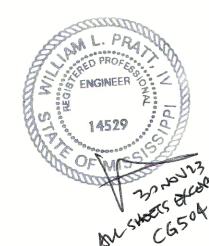

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NISSAN

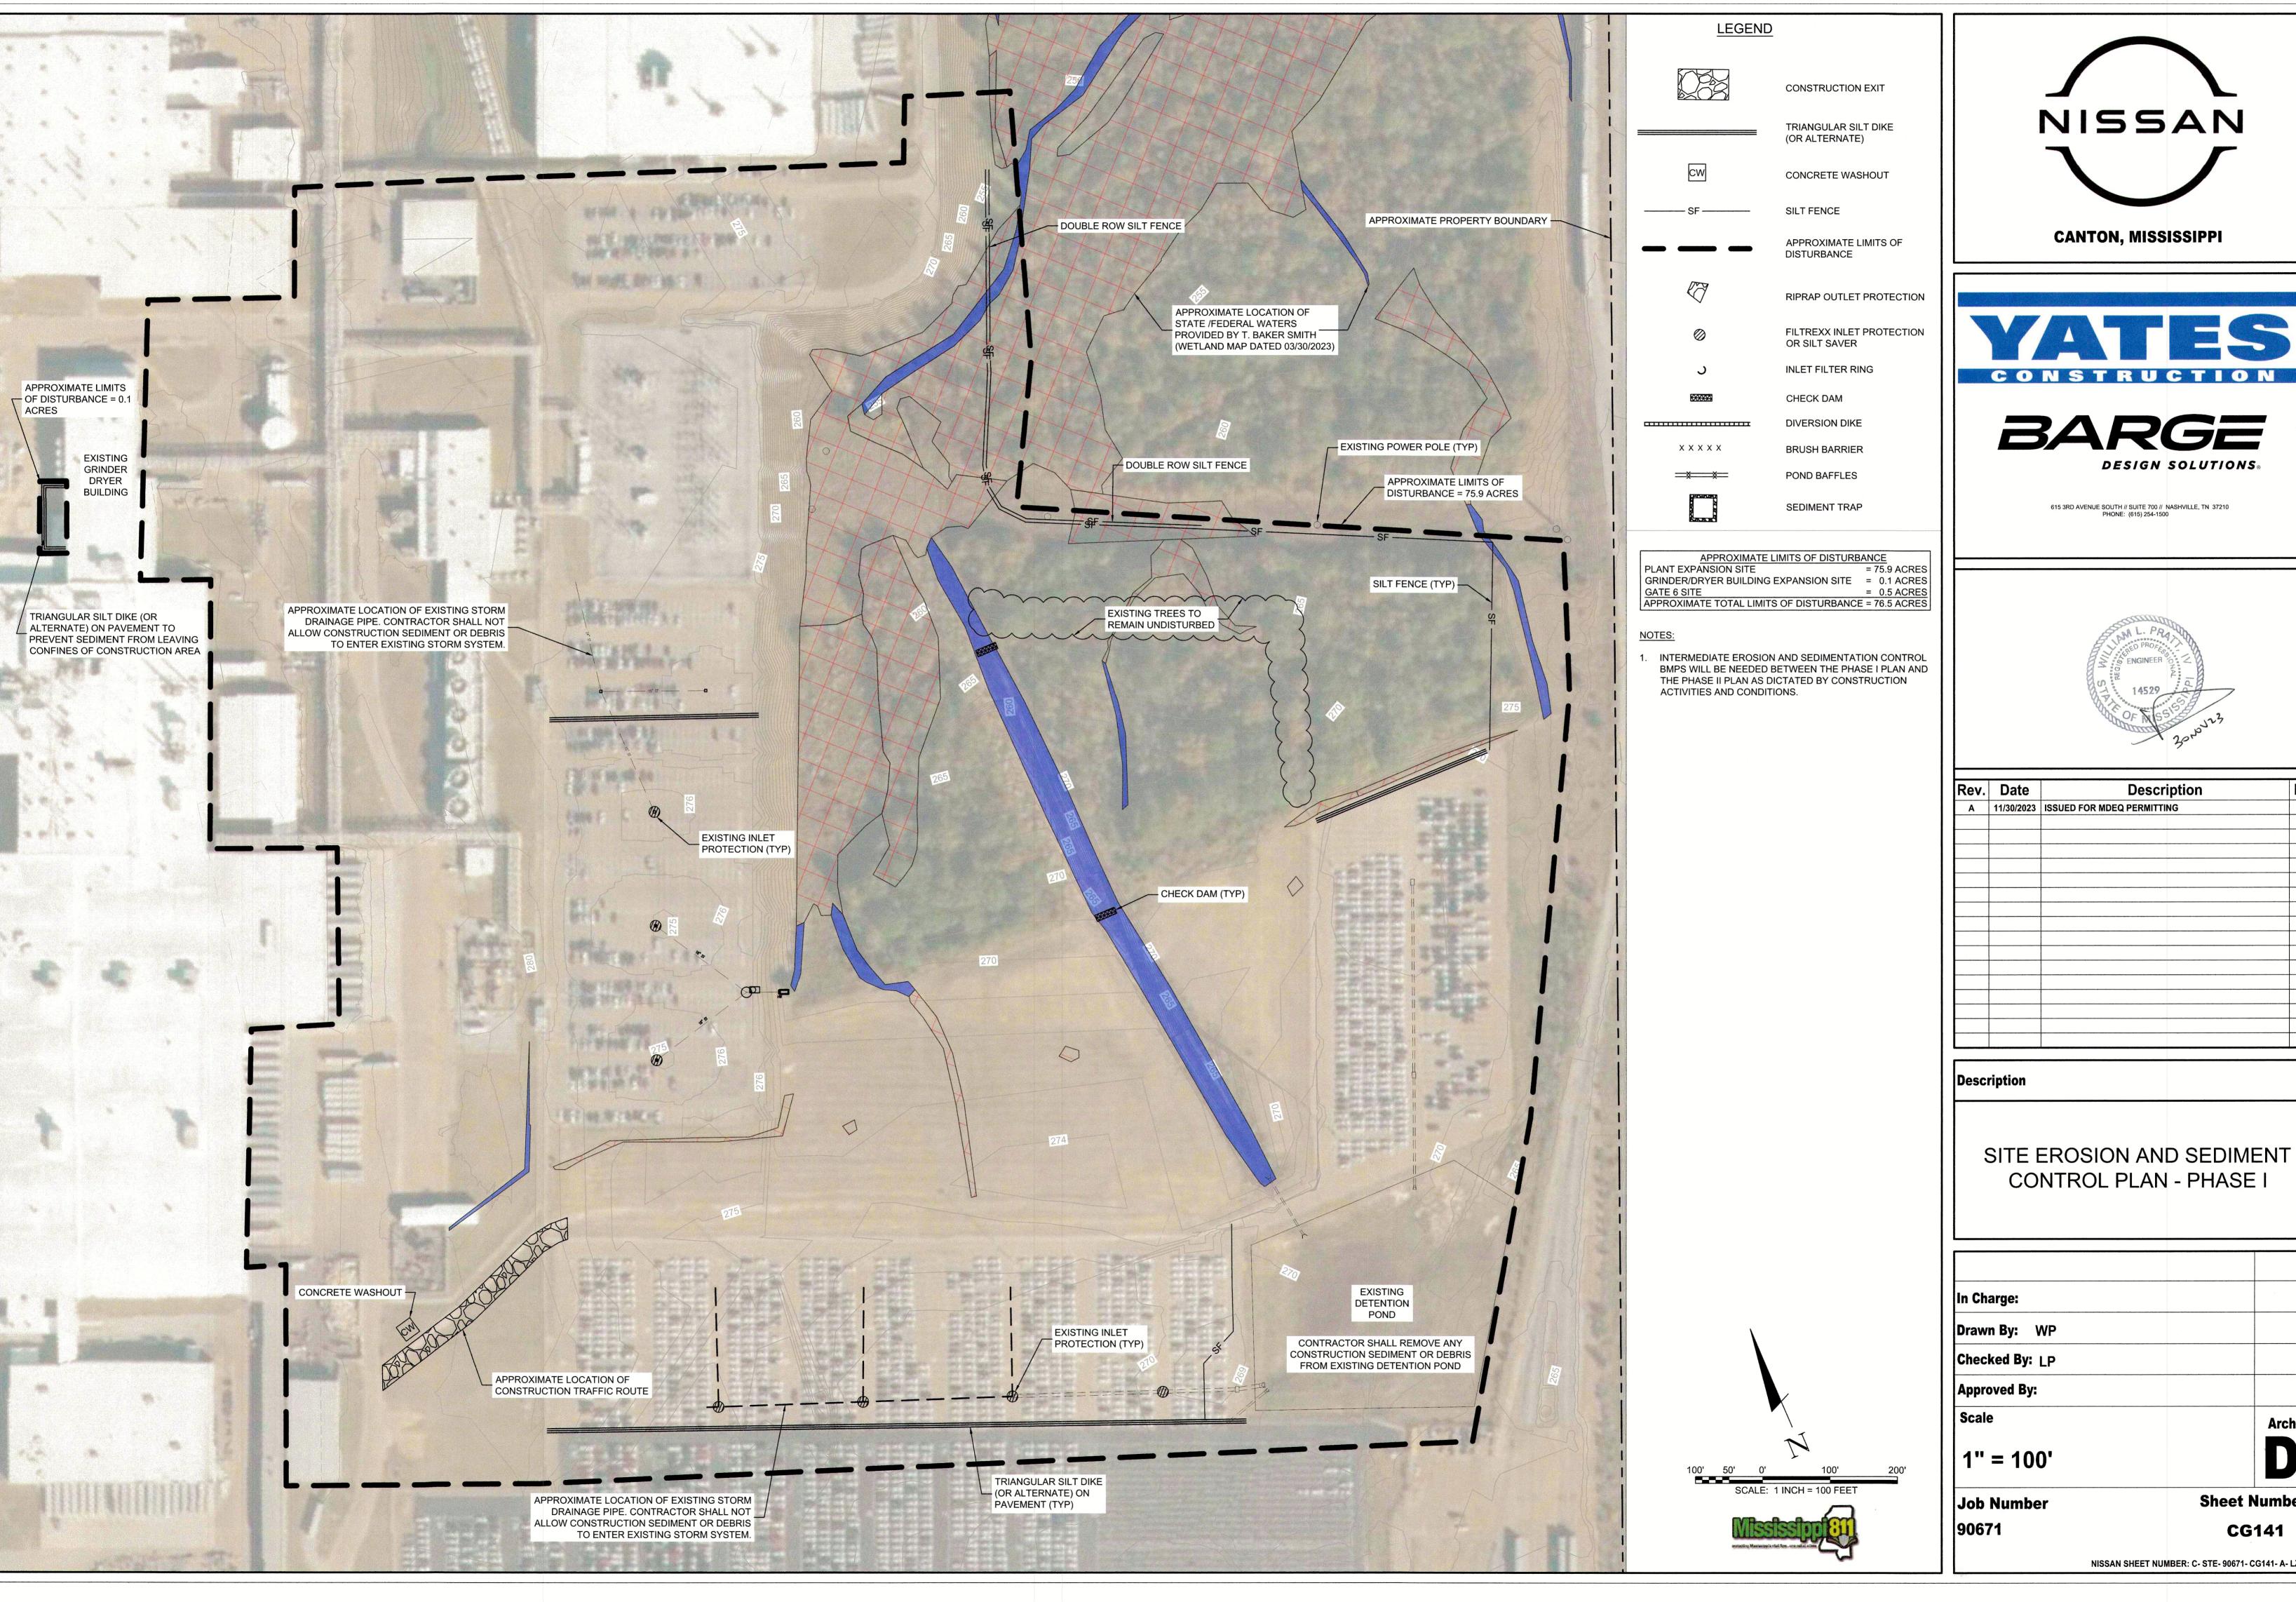






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CONTROL PLAN - PHASE I


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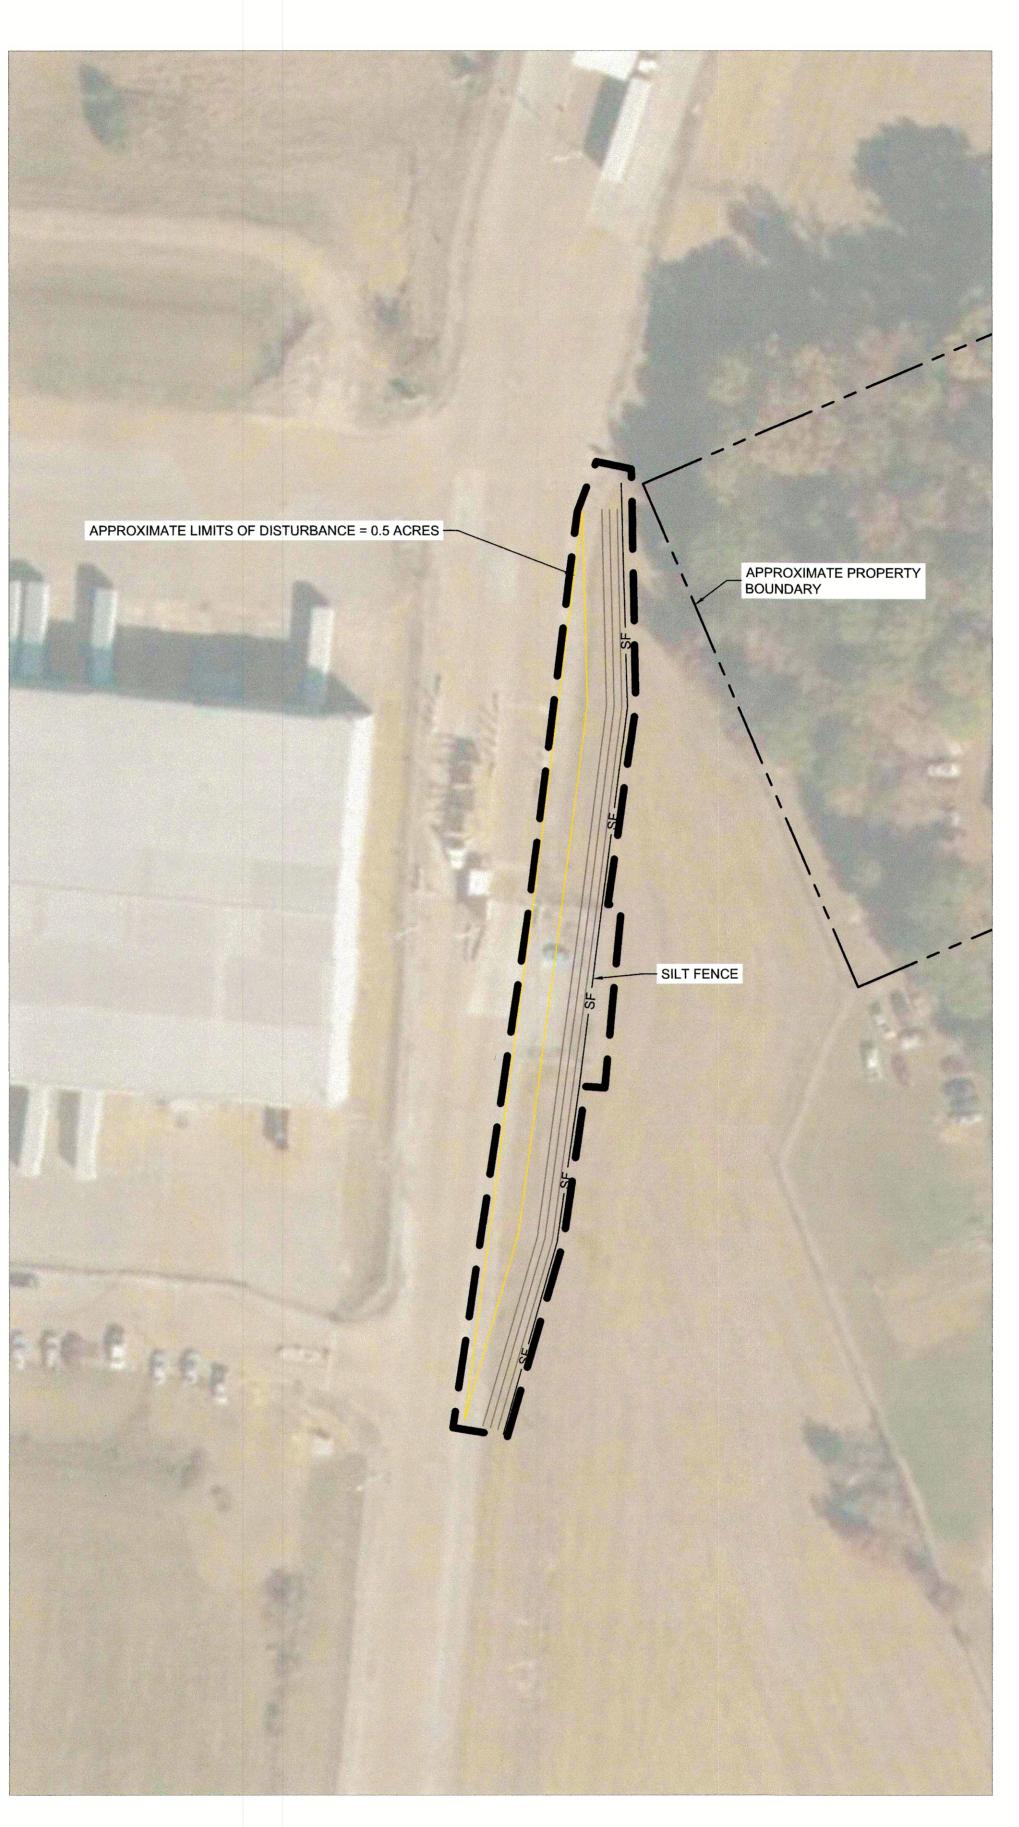
CG141

NISSAN SHEET NUMBER: C- STE- 90671- CG141- A- LZ1E/F



Rev.	Date	Description	Int.
Α	11/15/2023	PRELIMINARY DESIGN	
В	11/30/2023	ISSUED FOR MDEQ PERMITTING	
С	12/11/2023	ADDED SEDIMENT BASIN VOLUMES	

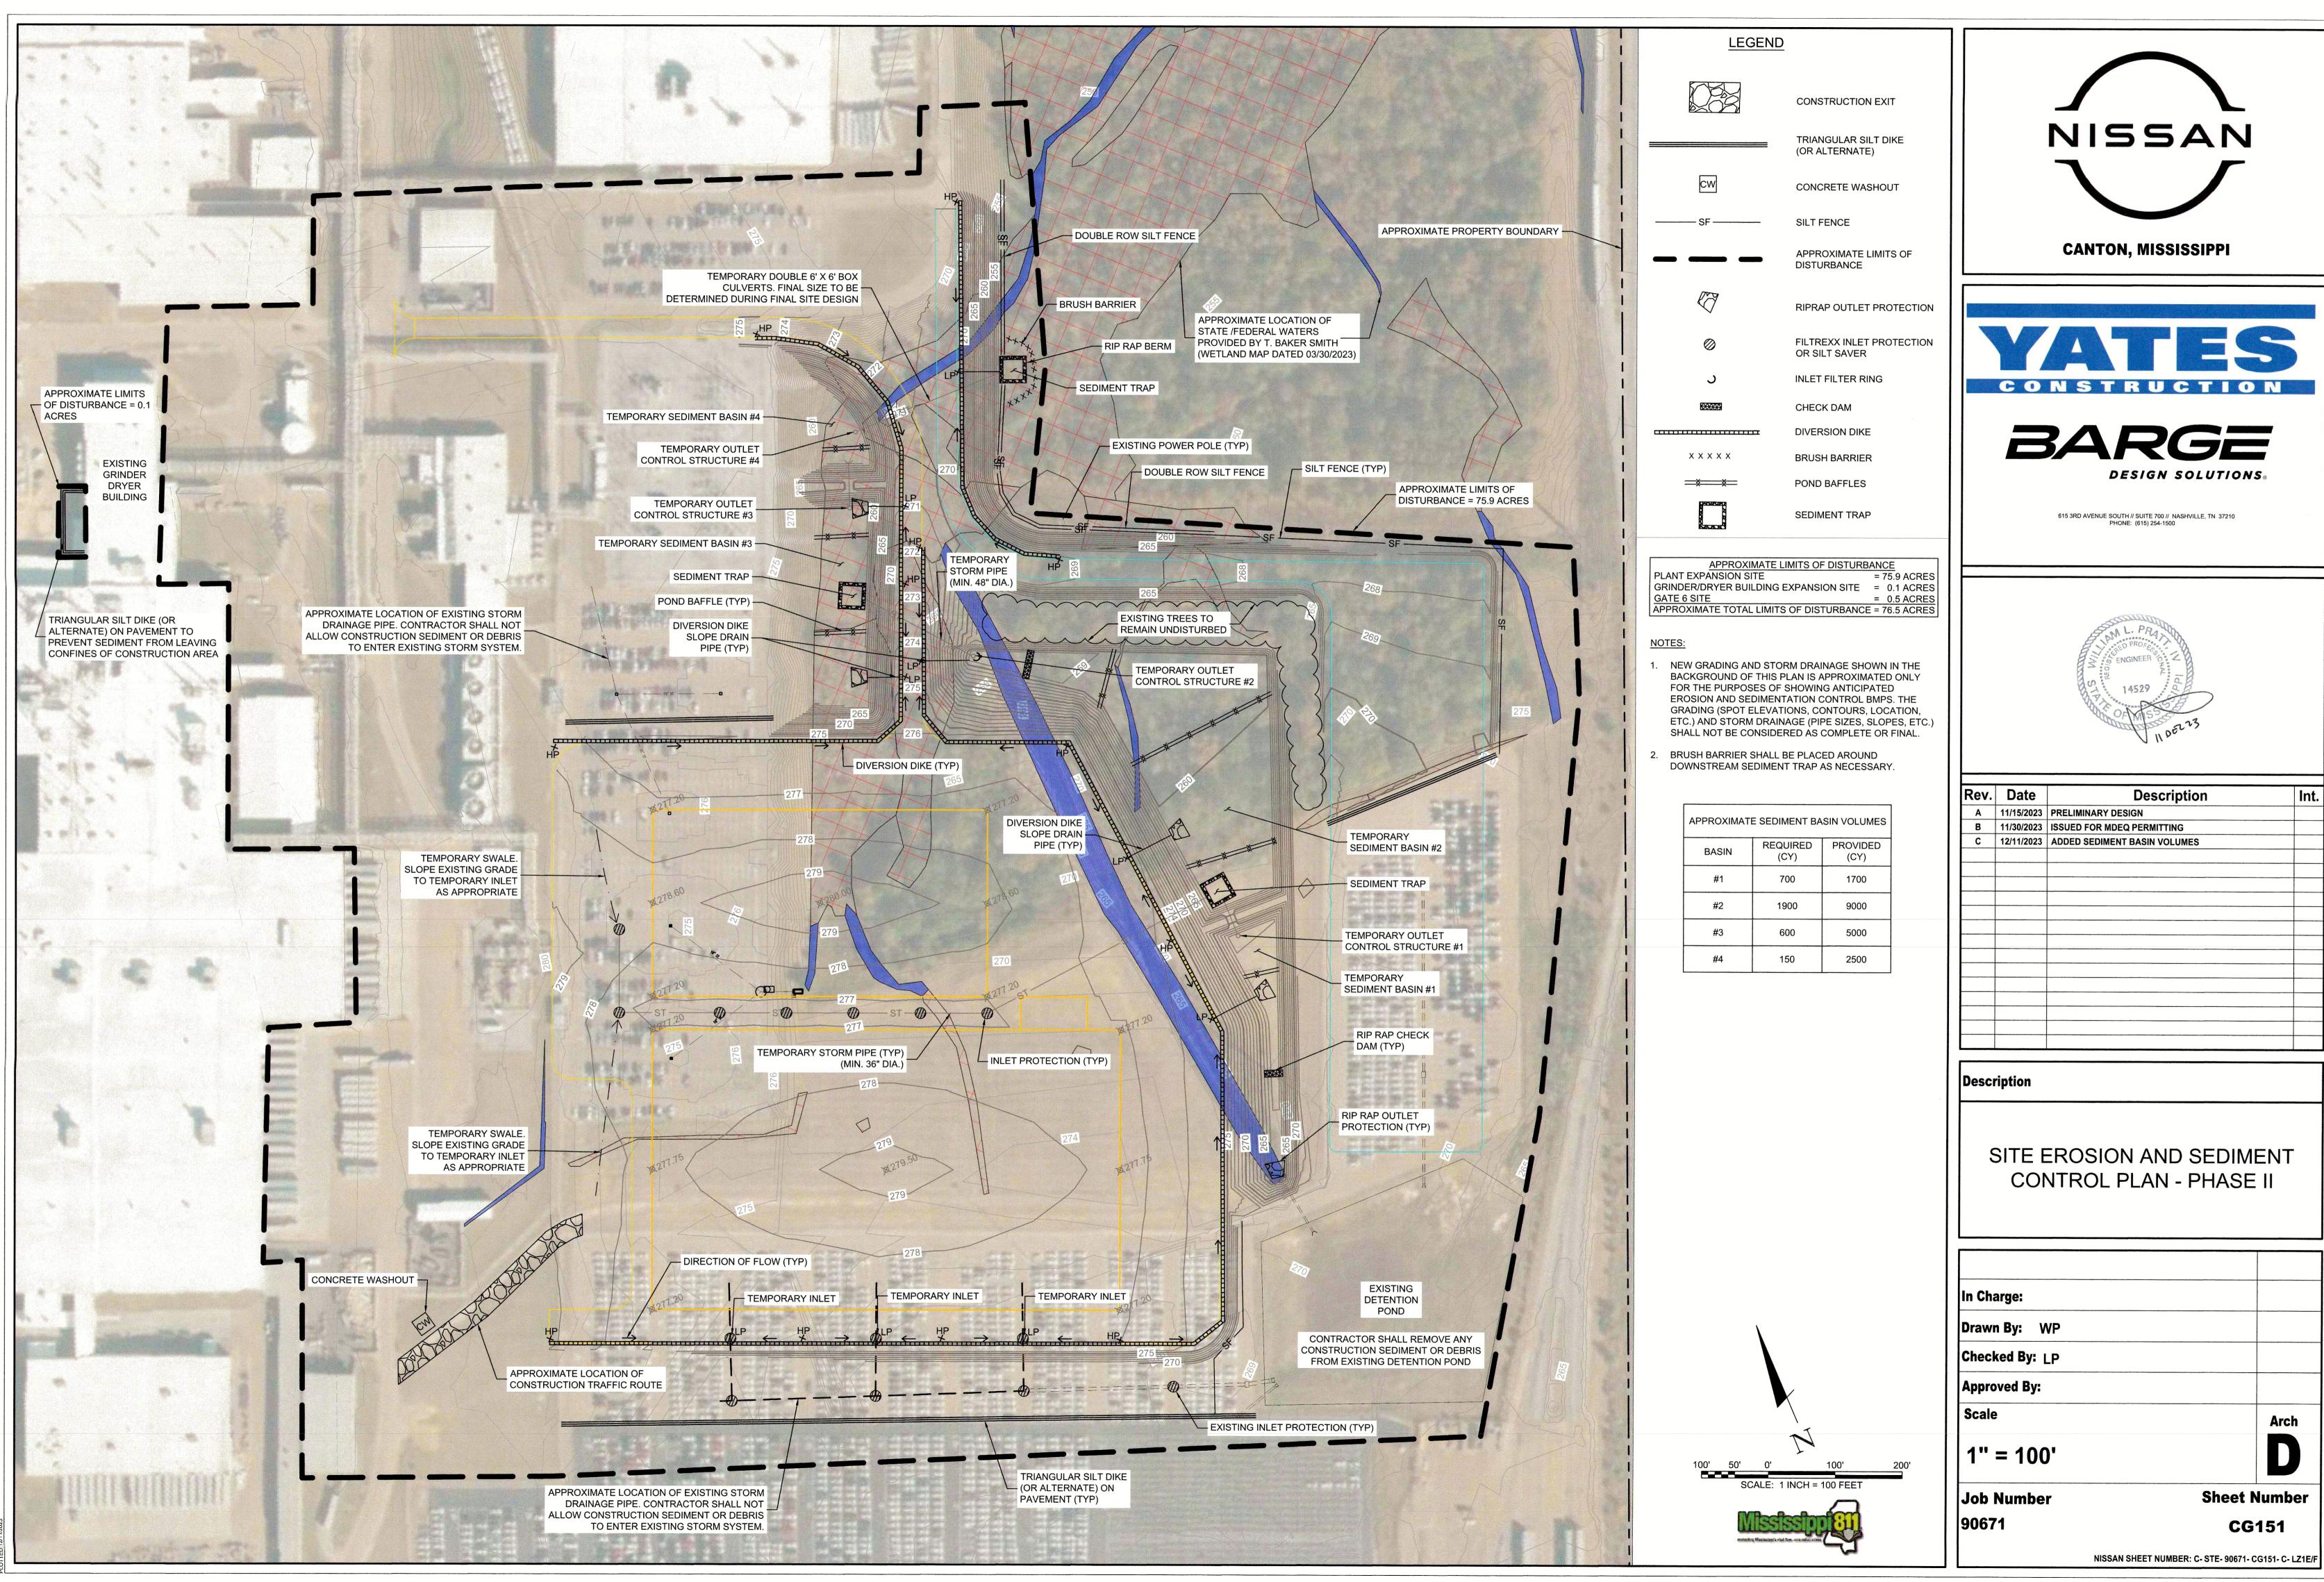

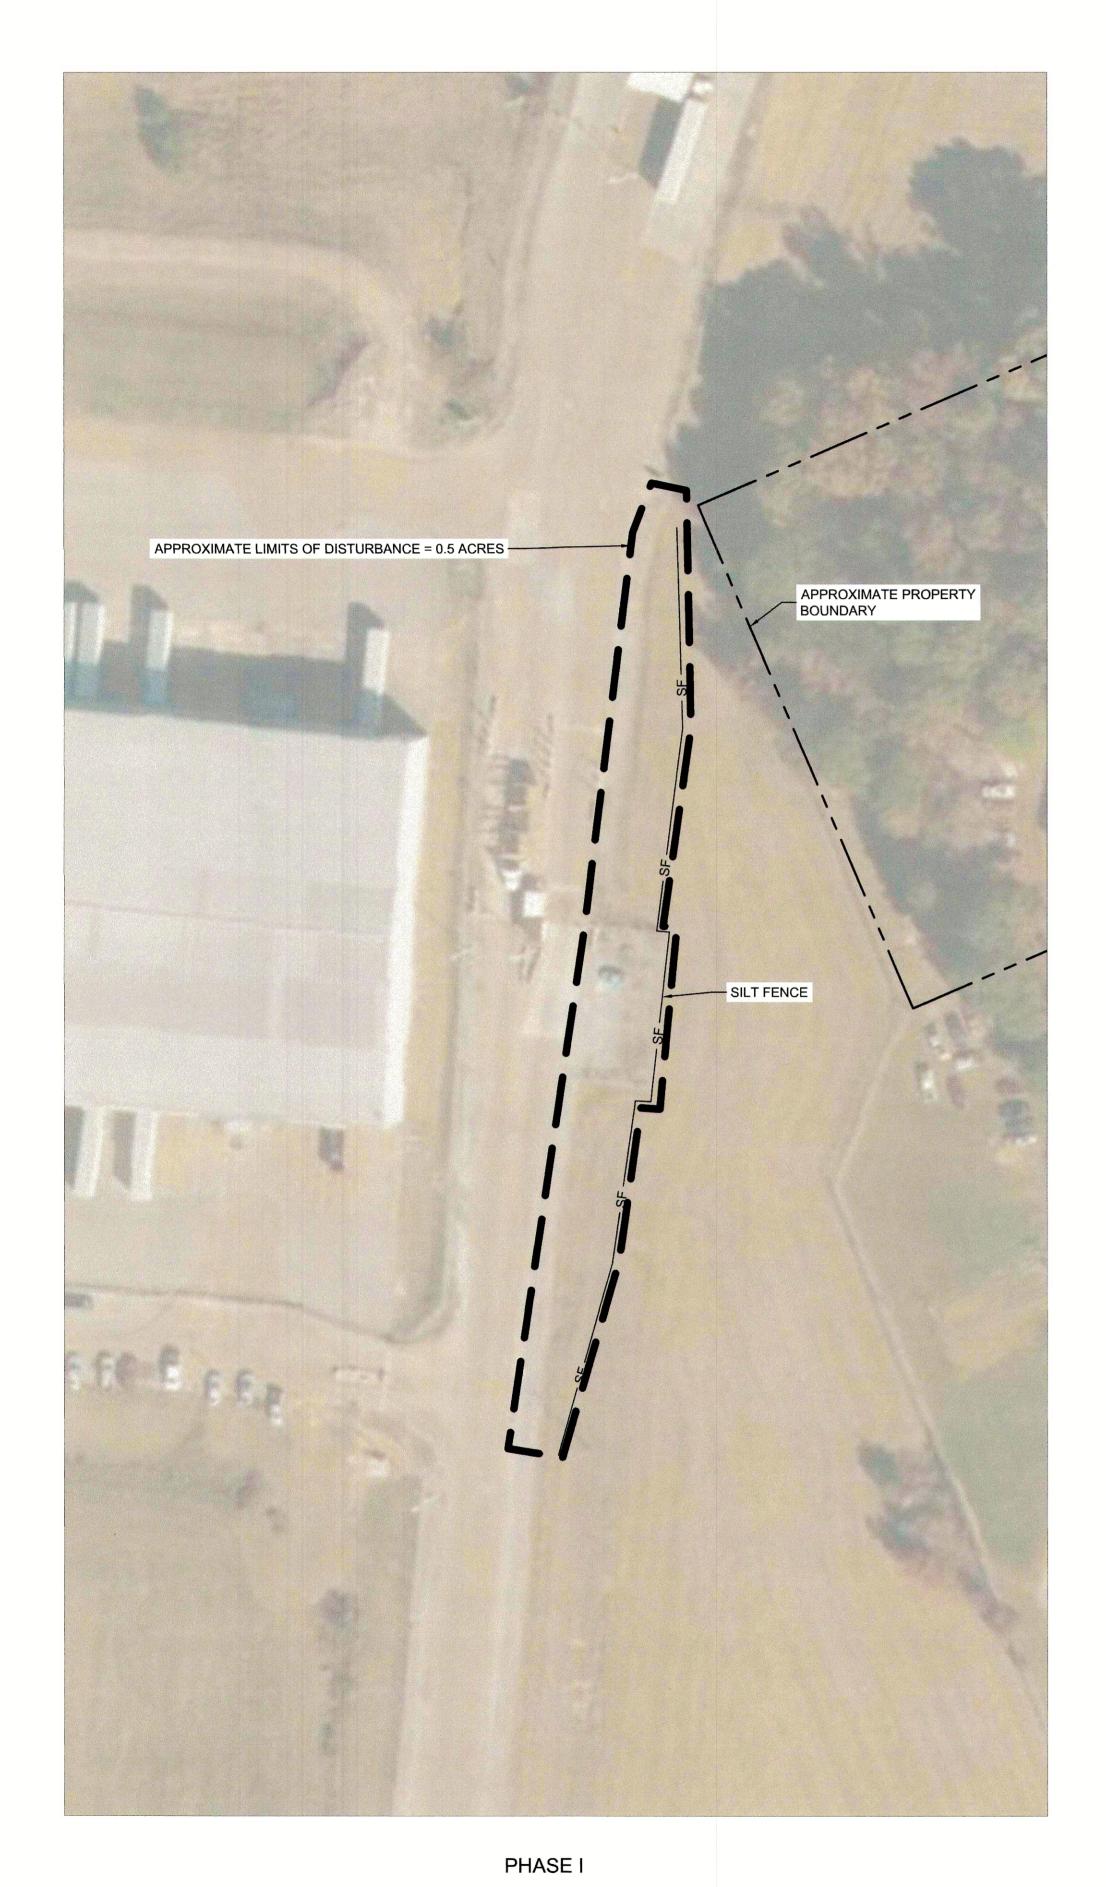

PHASE II

LEGEND

CONSTRUCTION EXIT



SILT FENCE

CONCRETE WASHOUT

APPROXIMATE LIMITS OF DISTURBANCE

RIPRAP OUTLET PROTECTION

FILTREXX INLET PROTECTION OR SILT SAVER

CHECK DAM **DIVERSION DIKE**

BRUSH BARRIER

INLET FILTER RING

X X X X X

POND BAFFLES

SEDIMENT TRAP

APPROXIMATE LIMITS OF DISTURBANCE
PLANT EXPANSION SITE = 75.9 ACRES
GRINDER/DRYER BUILDING EXPANSION SITE = 0.1 ACRES GATE 6 SITE = 0.5 ACRES
APPROXIMATE TOTAL LIMITS OF DISTURBANCE = 76.5 ACRES

- 1. NEW LAYOUT SHOWN IN THE BACKGROUND OF THIS PLAN IS APPROXIMATED ONLY FOR THE PURPOSES OF SHOWING ANTICIPATED GRADING AND EROSION AND SEDIMENTATION CONTROL BMPS.
- 2. NEW GRADING SHOWN IN THE BACKGROUND OF THIS PLAN IS APPROXIMATED ONLY FOR THE PURPOSES OF SHOWING ANTICIPATED EROSION AND SEDIMENTATION CONTROL BMPS. THE GRADING (SPOT ELEVATIONS, CONTOURS, LOCATION, ETC.) SHALL NOT BE CONSIDERED AS COMPLETE OR FINAL.
- 3. CONTRACTOR SHALL CONDUCT OPERATIONS SO AS TO NOT DISRUPT FACILITY OPERATIONS TRAFFIC.




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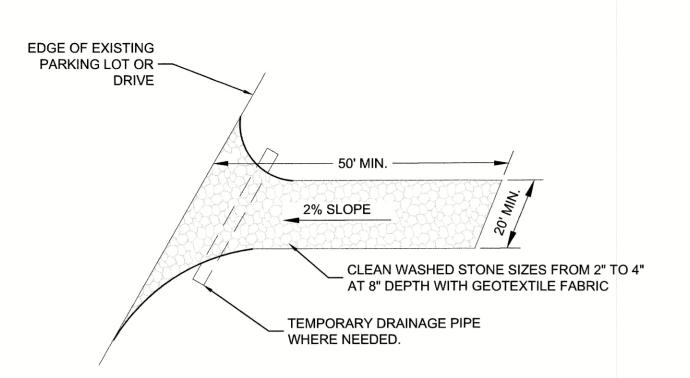
SITE EROSION AND SEDIMENT CONTROL PLAN - GATE 6

Job Number	Sheet Number
1" = 50'	
Scale	Arch
Approved By:	
Checked By: LP	
Drawn By: WP	
In Charge:	


Job Number 90671

CG161

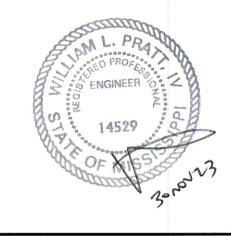NISSAN SHEET NUMBER: C- STE- 90671- CG161- A- LZ1E/F




PLAN VIEW OF TEMPORARY CONSTRUCTION EXIT

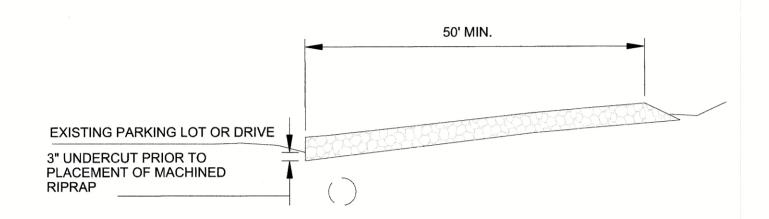

SECTION A-A


- 1. STONE FOR A STABILIZED CONSTRUCTION EXIT SHALL BE 2 INCH TO 4 INCH STONE, RECLAIMED STONE, OR RECYCLED CONCRETE EQUIVALENT.
- 2. THE LENGTH OF THE STABILIZED EXIT SHALL NOT BE LESS THAN 50 FEET.
- 3. THE THICKNESS OF THE STONE FOR THE STABILIZED EXIT SHALL NOT BE LESS THAN 8 INCHES.
- 4. THE WIDTH OF THE EXIT SHALL NOT BE LESS THAN THE FULL WIDTH OF THE EXIT WHERE INGRESS OR EGRESS OCCURS OR 20 FEET, WHICH EVER IS GREATER.
- 5. GEOTEXTILE FILTER CLOTH SHALL BE PLACED OVER THE ENTIRE AREA PRIOR TO PLACING THE STONE. FABRIC SHALL BE 12 OZ./S.Y. NON-WOVEN.
- 6. ALL SURFACE WATER THAT IS FLOWING TO OR DIVERTED TOWARD THE CONSTRUCTION EXIT SHALL BE PIPED BENEATH THE EXIT. IF PIPING IS IMPRACTICAL, A BERM WITH 5:1 SLOPES THAT CAN BE CROSSED BY VEHICLES MAY BE SUBSTITUTED FOR THE PIPE.
- 7. THE EXIT SHALL BE MAINTAINED IN A CONDITION THAT WILL PREVENT TRACKING OR FLOWING OF SEDIMENT ONTO PUBLIC RIGHTS-OF-WAY OR BEYOND THE CONSTRUCTION LIMITS. THIS MAY REQUIRE PERIODIC TOPDRESSING WITH ADDITIONAL STONE AS CONDITIONS DEMAND AND REPAIR AND/OR CLEANOUT OF ANY MEASURES USED TO TRAP SEDIMENT. ALL SEDIMENT SPILLED, WASHED, OR TRACKED ONTO PUBLIC RIGHT-OF-WAY MUST BE REMOVED PROMPTLY.



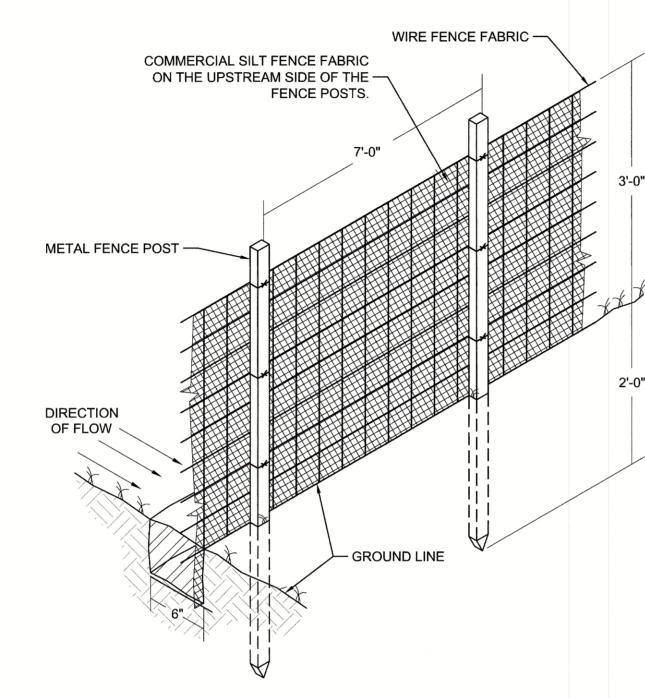


- 1. EXCAVATE THE TRENCH 6" BELOW THE EXISTING GROUND LINE
- 3. BACKFILL AND COMPACT THE TRENCH, COVERING THE FABRIC.
- 4. CONTINUOUSLY REMOVE TRAPPED SEDIMENT.


2. INSTALL THE FABRIC TO THE BOTTOM OF THE TRENCH.

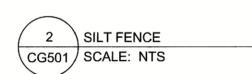


NOTES:

- 1. ALL MATERIAL TO MEET FILTREXX® SPECIFICATIONS.
- 2. FILTER MEDIA™ FILL TO MEET APPLICATION REQUIREMENTS.
- 3. COMPOST MATERIAL TO BE DISPERSED ON SITE, AS DETERMINED BY OWNER.
- 4. FILTREXX SOXX SHALL BE INSPECTED AND CLEANED / RE-STAKED AS NECESSARY ON A DAILY BASIS.

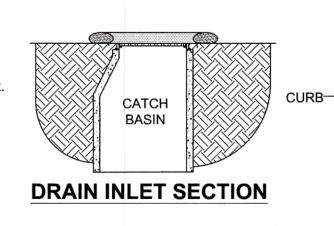

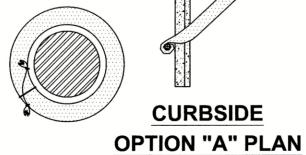

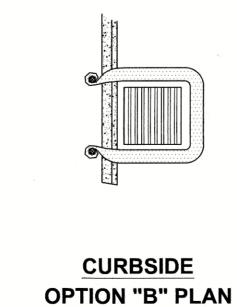





CURBSIDE SECTION

CATCH BASIN



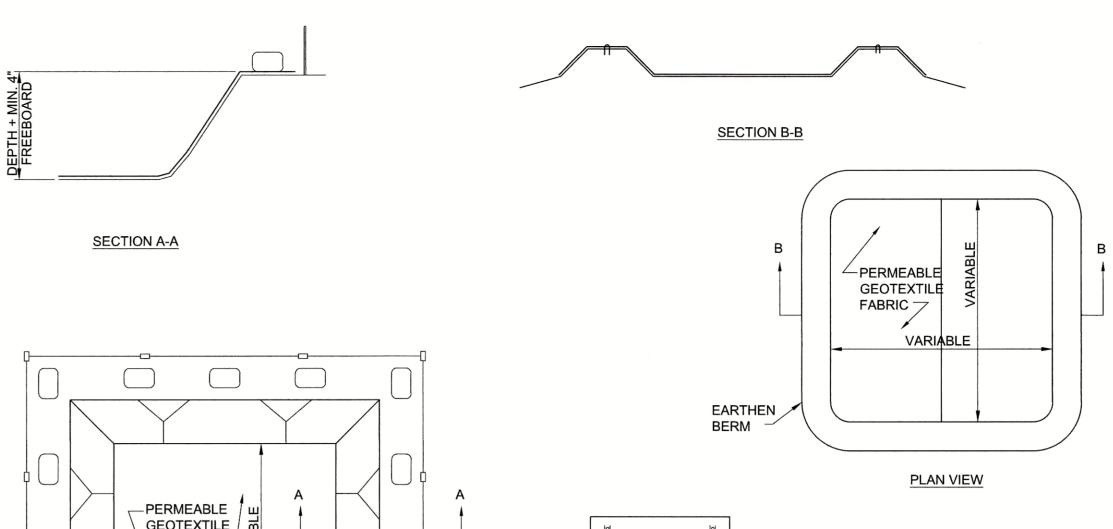

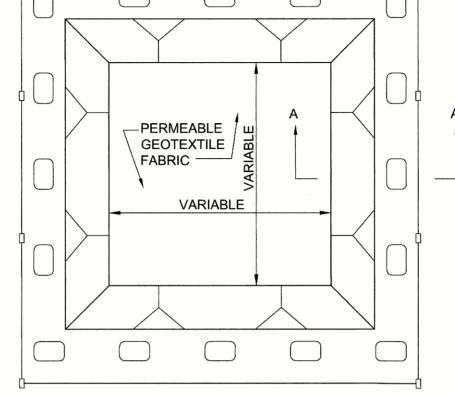

PLAN VIEW


TYPE "BELOW GRADE"

CONCRETE WASHOUT CONCRETE WASHOUT SIGN (OR EQUIVALENT)

1. ACTUAL LAYOUT DETERMINED IN THE FIELD. 2. SIGNAGE IDENTIFYING THE CONCRETE WASHOUT AREA SHALL BE INSTALLED WITHIN 5FT. OF THE WASHOUT FACILITY.

TYPE "ABOVE GRADE" WITH EARTHEN BERMS

3. DEPTH SHALL BE 2' MIN. OR PER LOCAL REQUIREMENTS, WHICHEVER IS GREATER.

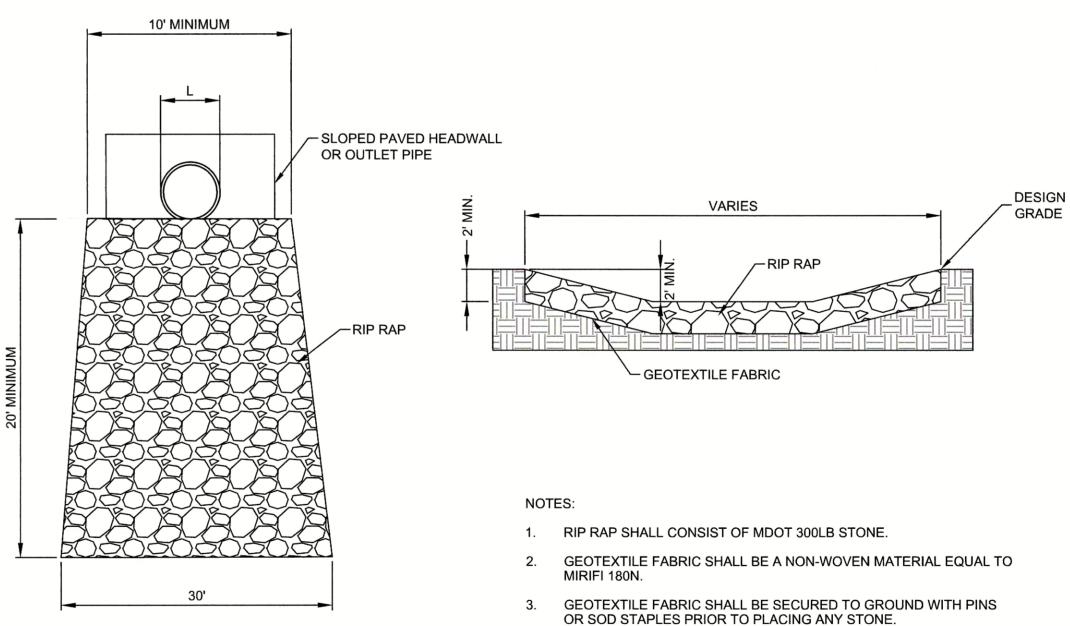


3 \ CONCRETE WASHOUT

CG501 SCALE: NTS



THE RIP RAP SHALL HAVE A UNIFORM THICKNESS NO LESS THAN 2'.

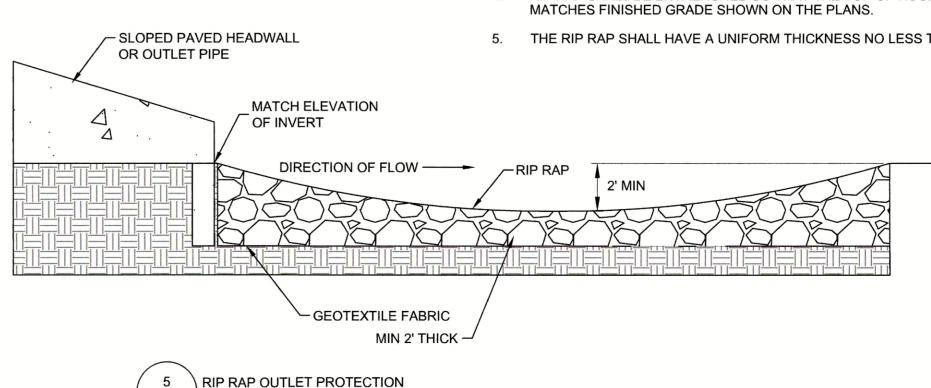

CG501 | SCALE: NTS



YATTES CONSTRUCTION

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Description

EROSION CONTROL DETAILS


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Checked By: LP	
Drawn By: WP	
In Charge:	

Job Number

90671

Sheet Number CG501

NISSAN SHEET NUMBER: C- STE- 90671- CG501- A- LZ1E/F

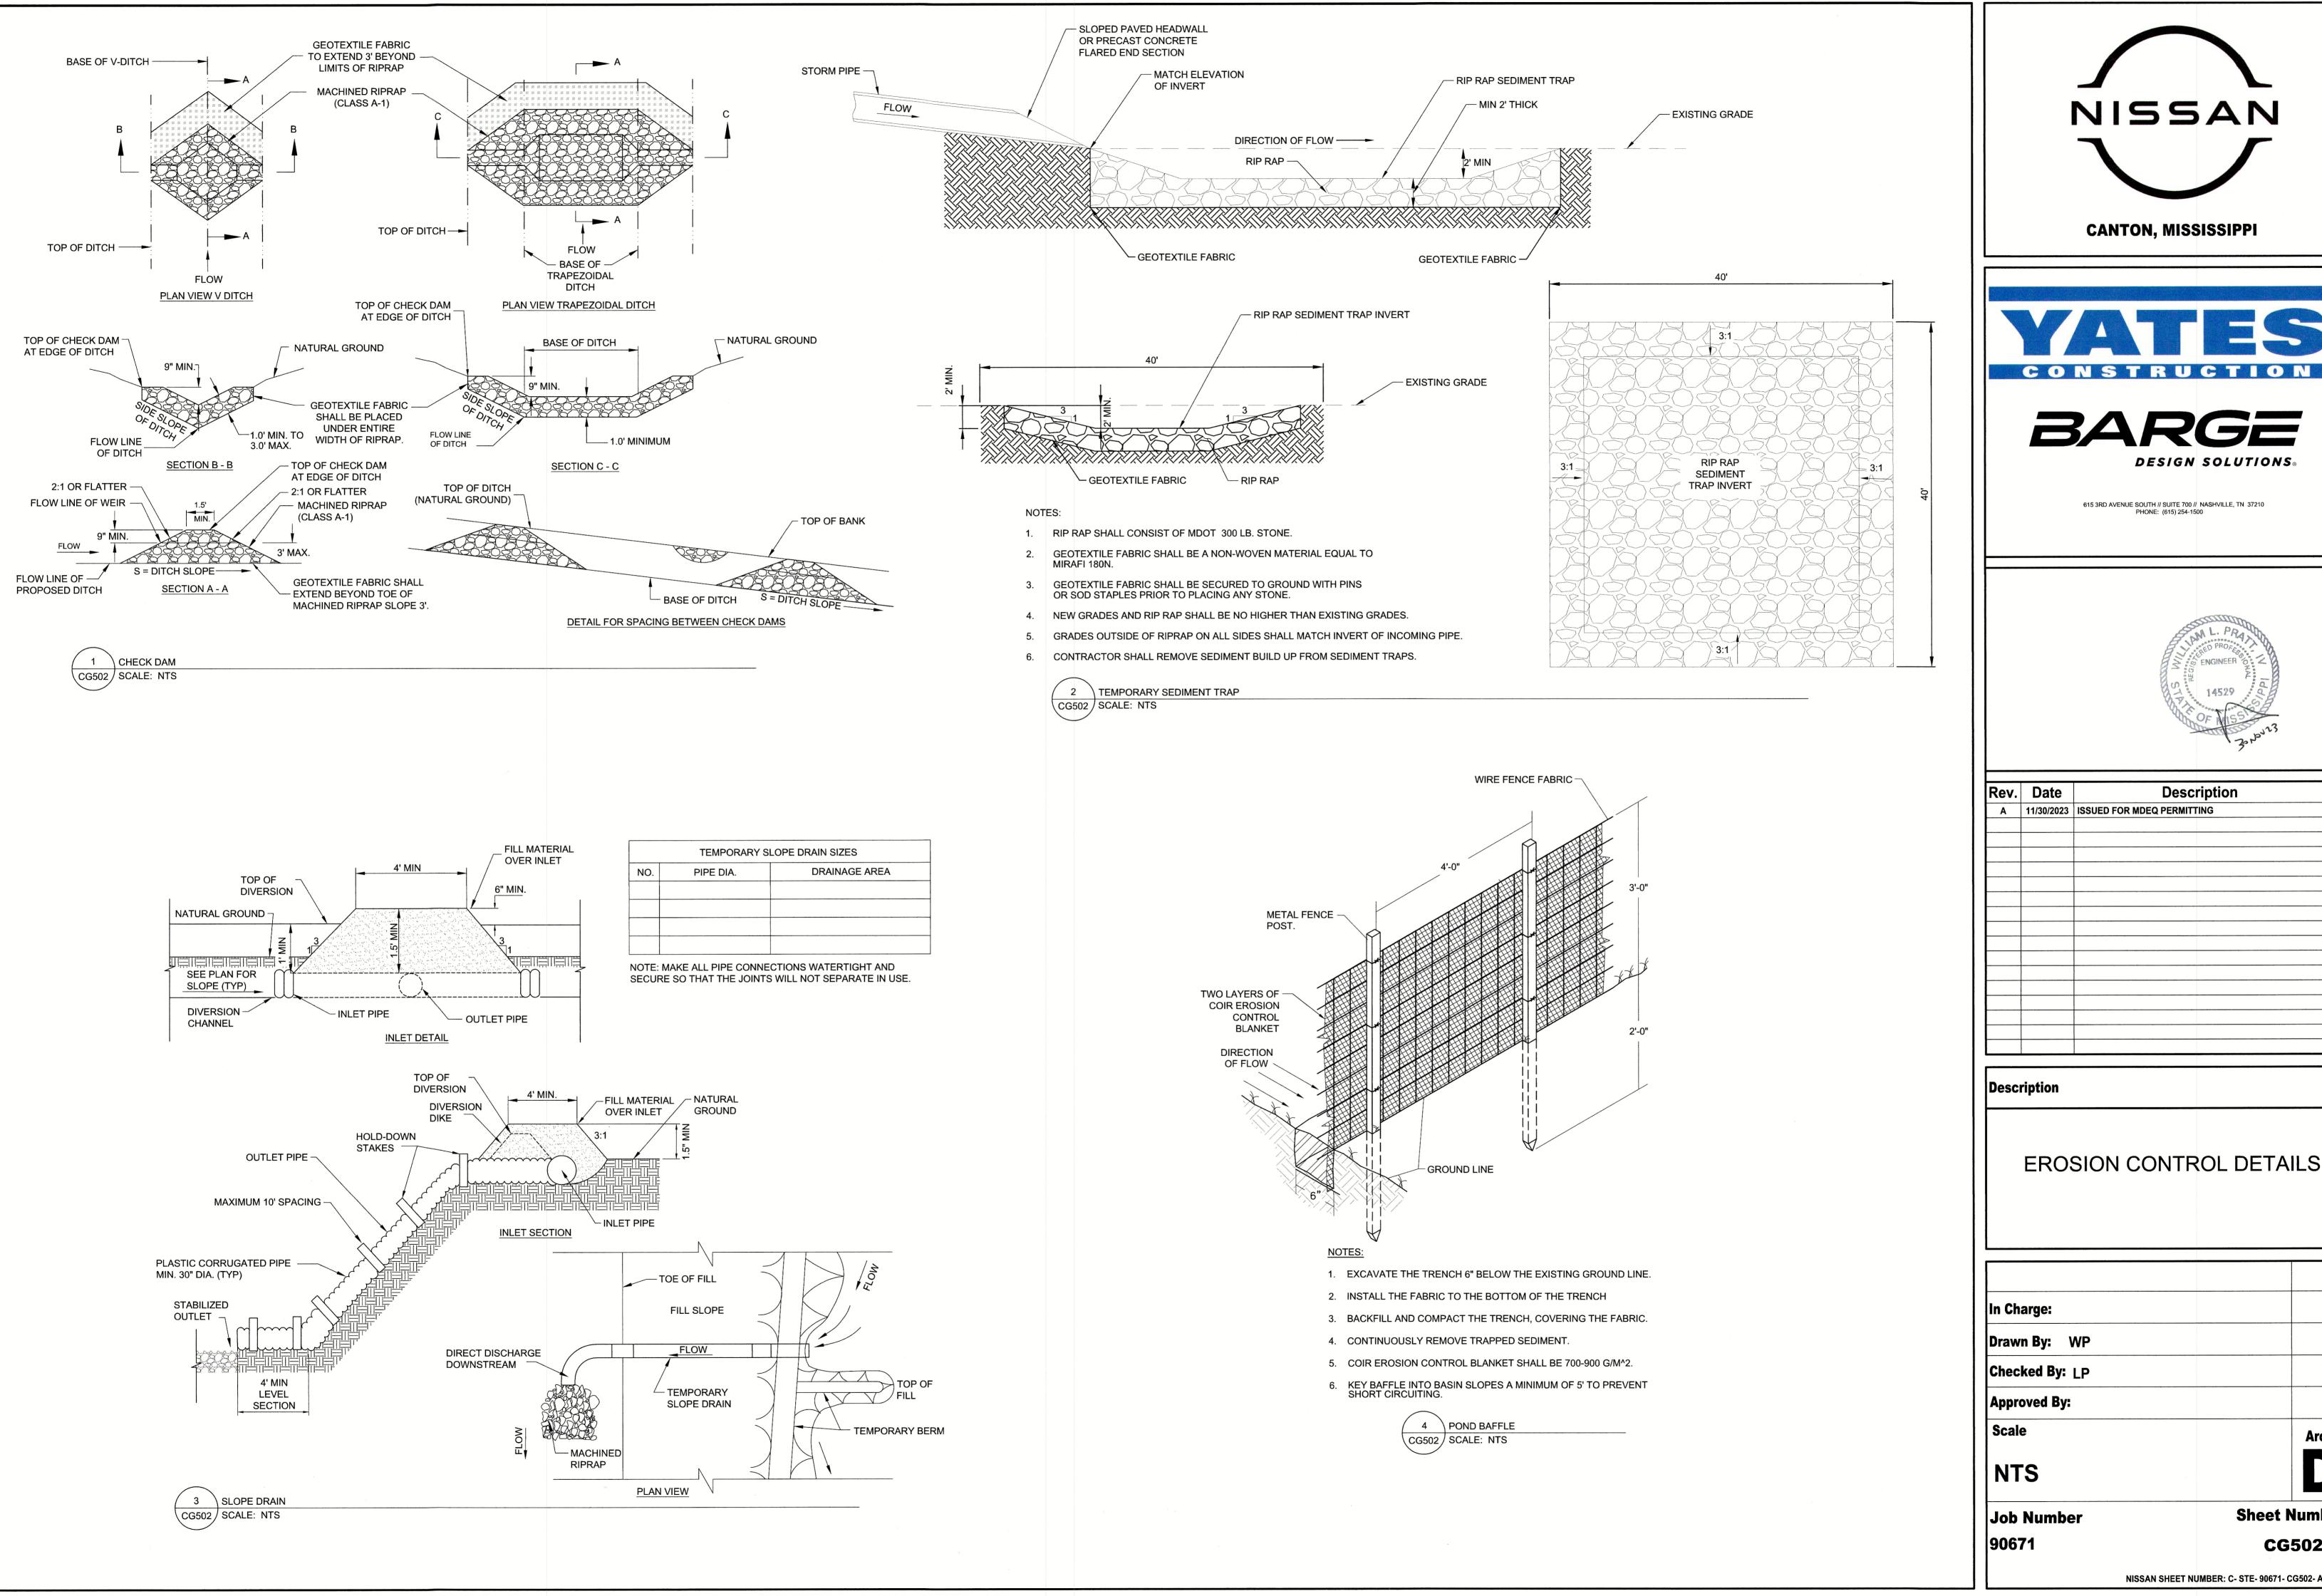



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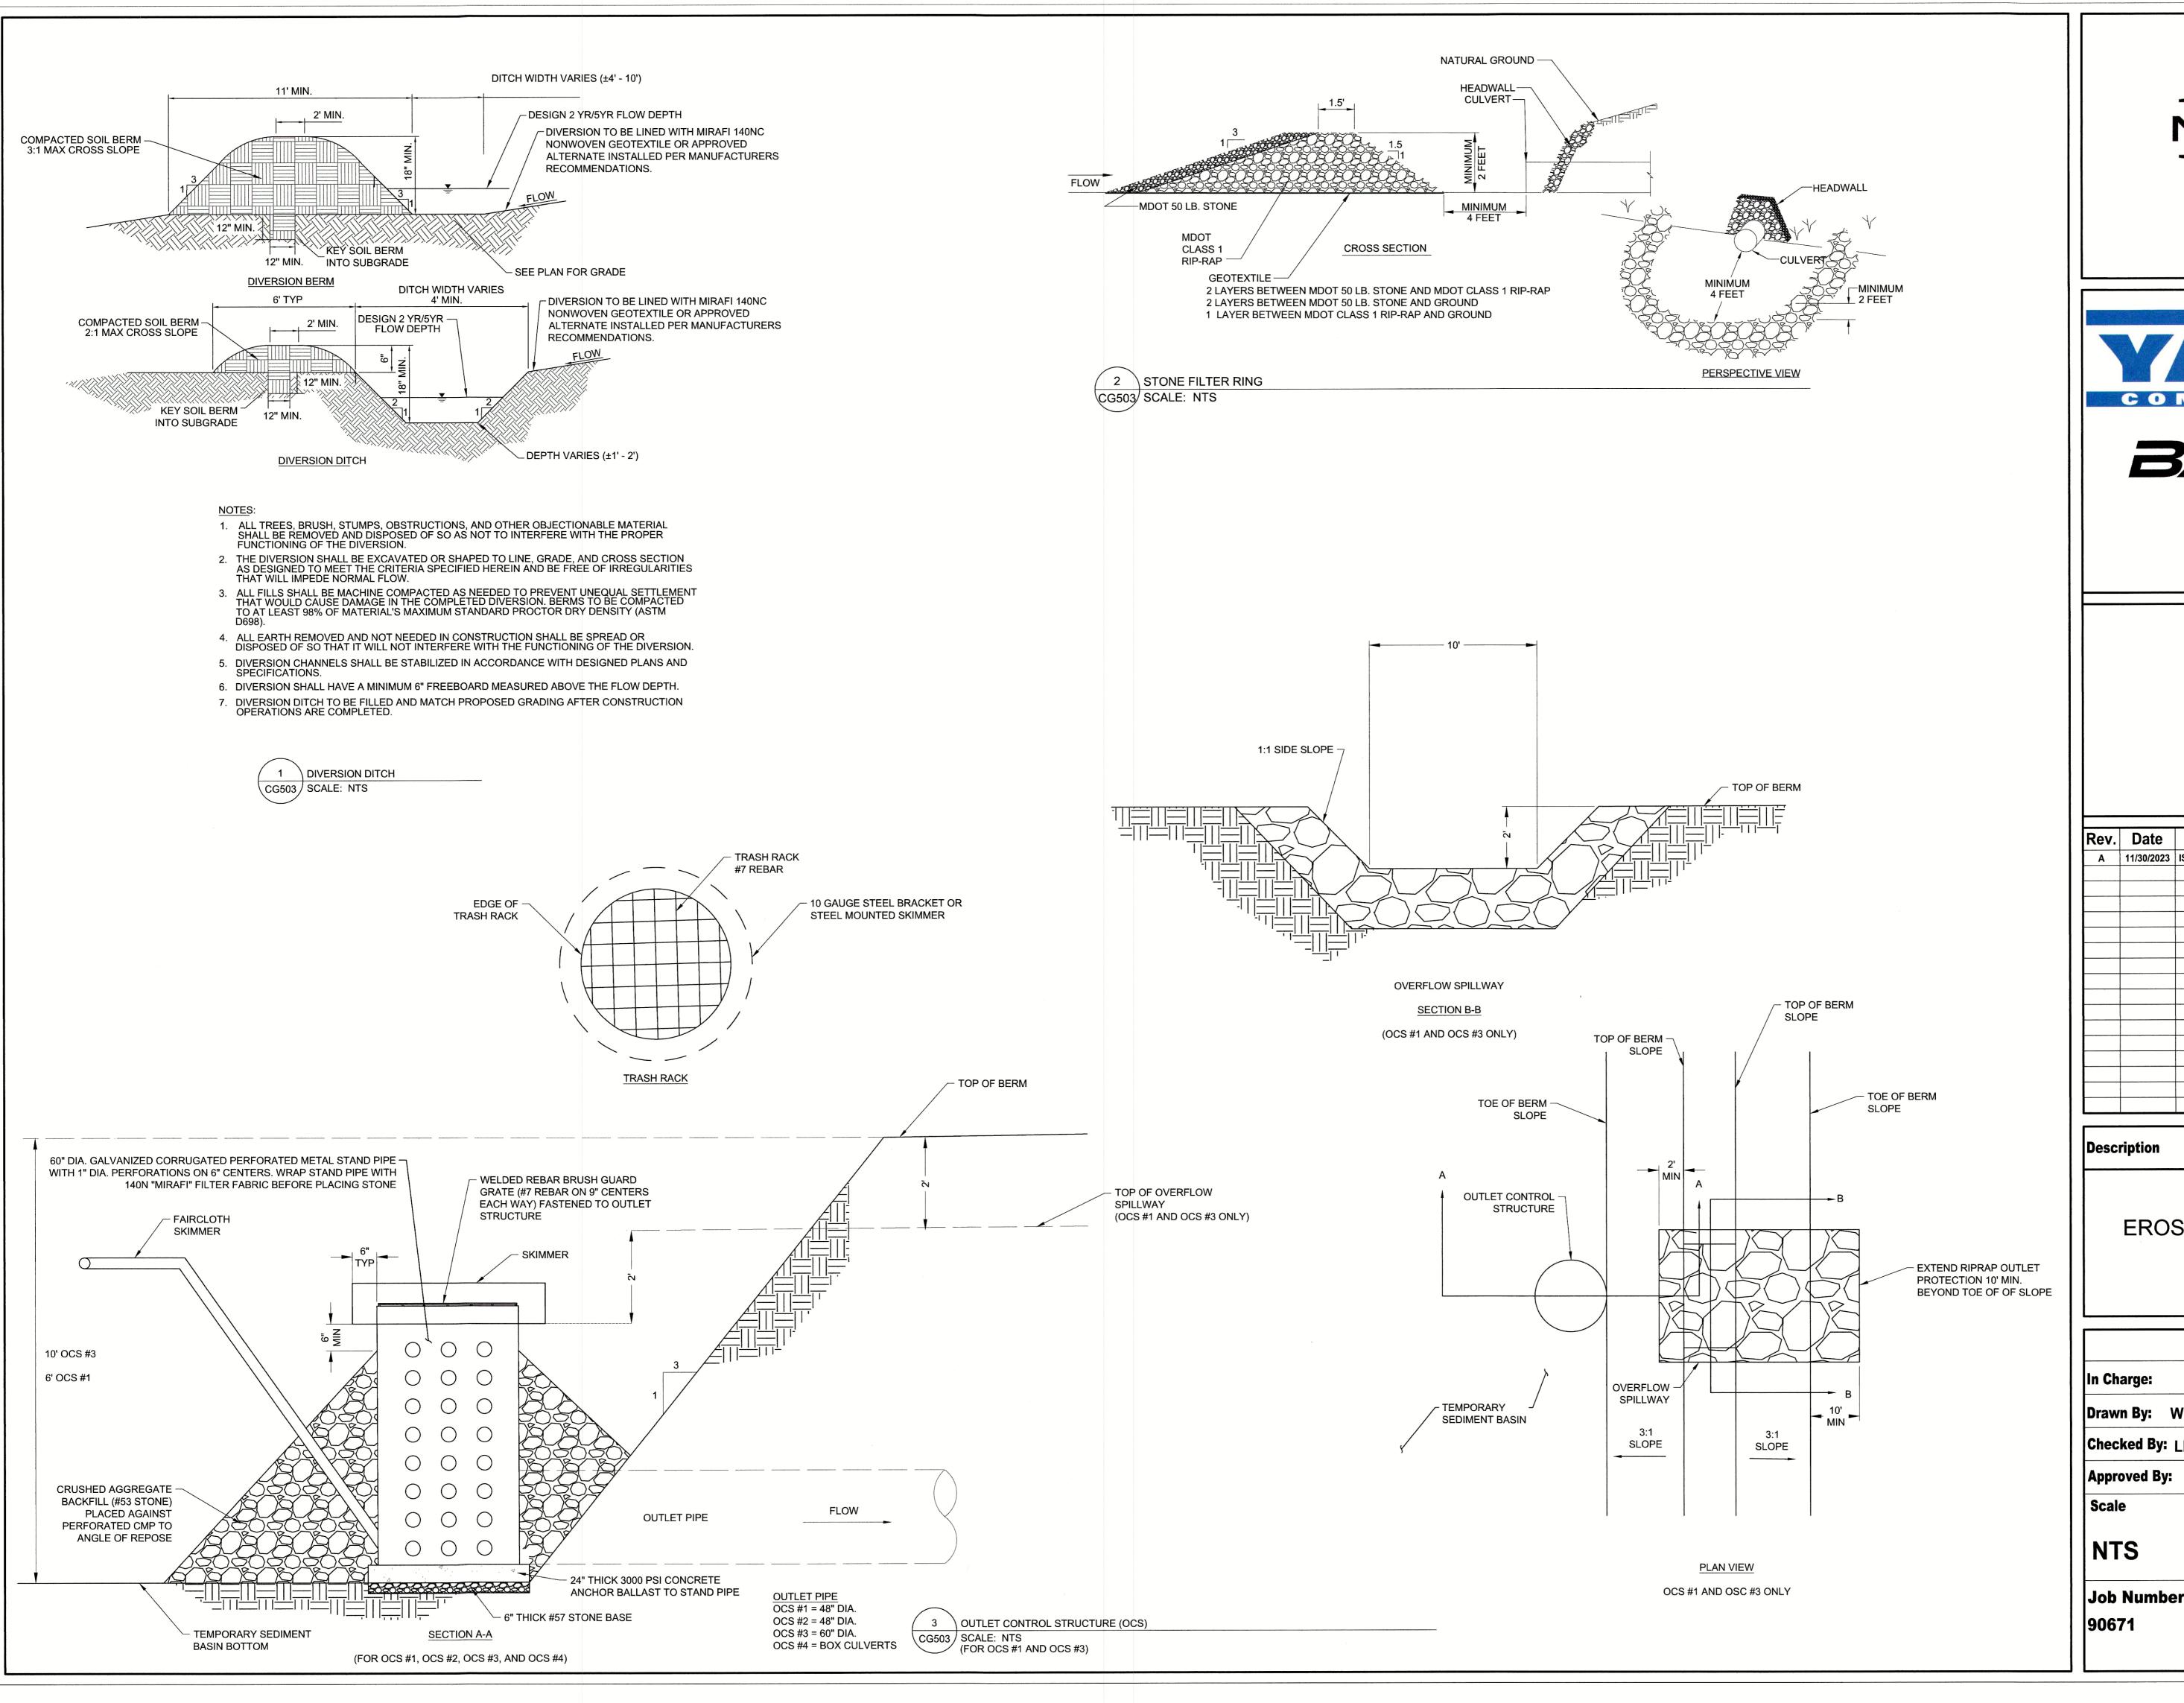
Description

EROSION CONTROL DETAILS

Job Number

Sheet Number CG502

NISSAN SHEET NUMBER: C- STE- 90671- CG502- A- LZ1E/F





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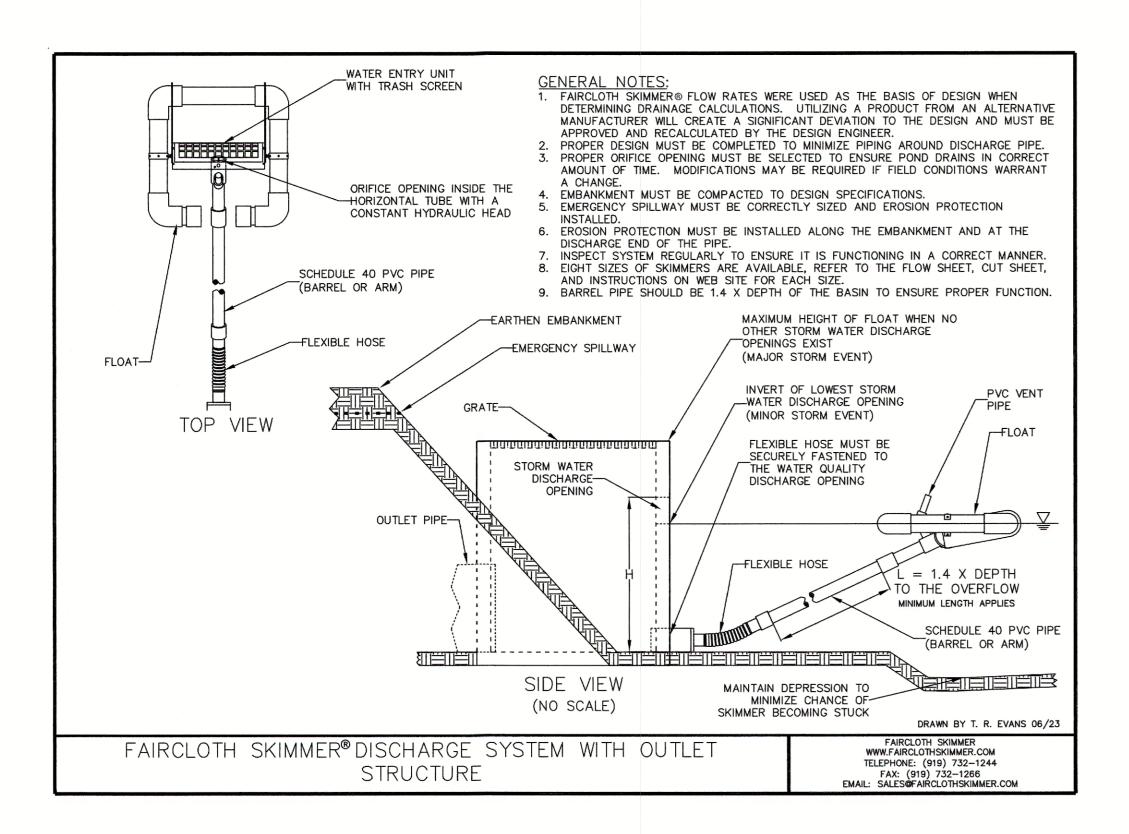
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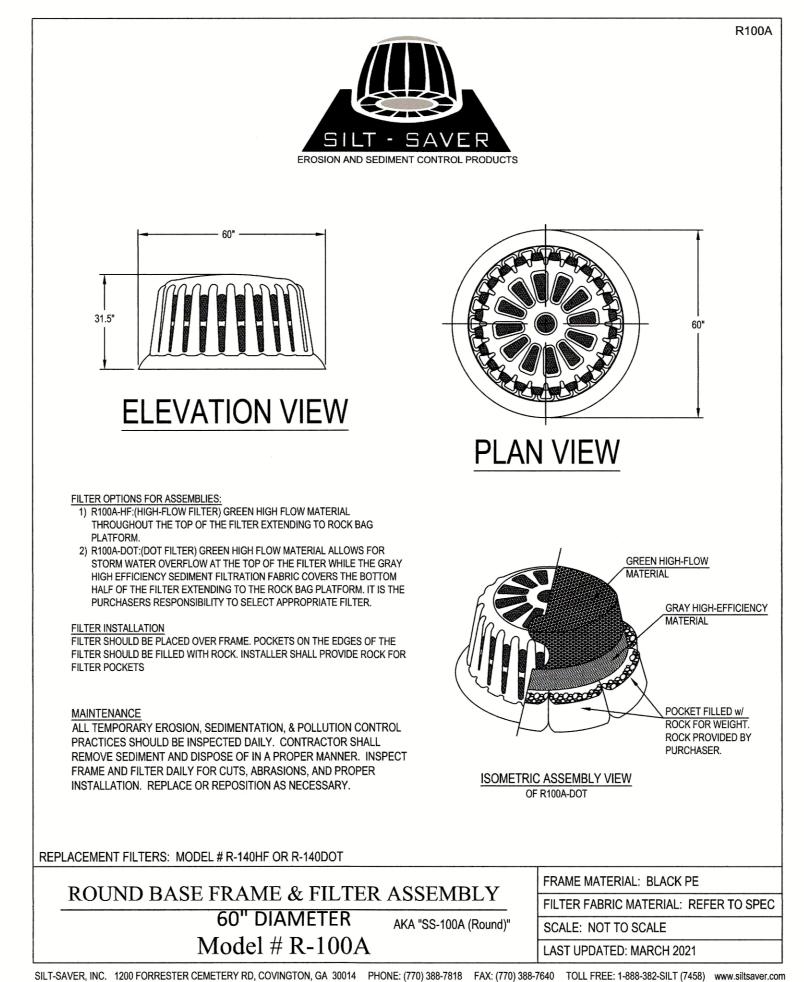
EROSION CONTROL DETAILS

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CG503











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EROSION CONTROL DETAILS

In Charge:		
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Job Number	Sheet Number	
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NISSAN SHEET NUMBER: C- STE- 90671- CG504- A- LZ1E/F

Discipline Sort: 0403

Drawing: CG504

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